arqivo

Trevor Woodhouse Asset Surveyor

Trevor.woodhouse@arqiva.com Direct tel +44 (0)1707 624517 Direct fax +44 (0)1707624511 Mobile +44 (0)07951 030048

Head of Planning Services
Babergh District Council
Planning Services BABERGH DISTRICT COUNCIL

PLANNING DEPARTMENT

- 3 FEB 2009

B/09/00122

BABERGH DISTRICT
COUNCIL
- 2 FEB 2009
POST ROOM

BABERGH DISTRICT COUNCIL

Dear Sir/Madam

Ipswich IP7 6SJ

Corks Lane

Hadleigh

DIGITAL SWITCHOVER PROJECT SUDBURY TRANSMITTING STATION, YORLEY FARM, LITTLE CORNARD, SUDBURY, SWUFFOLK, CO10 0NZ SUBMISSION OF PRIOR APPROVAL APPLICATION

We refer to our letter dated 16th April 2008 and the proposal to install wrap around antennas on the existing mast under Part 24 of the General Permitted Development Order 1995 (as amended). Please find attached revised drawings showing the latest proposals.

As will be explain explained, two major factors have changed since the letter was sent. First, National Grid Wireless, who owned and operated the BBC transmission network, has been taken over by its fellow broadcast company Arqiva, who own and operate the former Independent Broadcasting Authority network. This brings into single ownership the whole of the terrestrial television broadcast networks and both companies now operate under the Arqiva brand. Second, as the Digital Switchover project has progressed in other parts of the UK, more practical experience has been gained of this kind of complex engineering project.

The combined effect of these factors now means that it now necessary to install external heat exchangers to dissipate the heat generated from the new ground based transmission equipment that will be installed within the existing building complex. In addition, a new generator and associated fuel tank will need to be installed in the event of a power failure when the site is switched over to digital. Apart from monthly testing for a short period, the generator would only operate in extreme circumstances. Housing the proposed generator within existing building complex has been considered, but unfortunately there will not be enough space once the new ground based transmission equipment is installed.



We are proposing to install the heat exchangers and generator as close to the associated transmission equipment they will serve within the existing building complex so that the heat exchangers can work at maximum efficiency and without obstructing the service road that currently surrounds the building complex

As we are Electronic Communications Code Operators, we benefit from the permitted development rights set out under Part 24 of Schedule 2 of the Town and Country Planning (General Permitted Development) Order 1995, as amended (the GPDO). As this apparatus is ancillary to radio equipment housing, it falls under the prior approval procedures set out under Condition 3 of the relevant part of the GPDO. We accordingly make an application as to whether your Council's prior approval is required for the detailed siting and appearance of the apparatus we propose to install and to assist, we enclose the following:

- i. Location plan 10016.2.14/02.
- ii. Drawing nos. 10016_50_150_M18_18, 10016_50_101_M18_18, 10016_100_100_M18_18, 10016_50_160_M18_18
- iii. Supplementary information on the heat exchangers and generator
- iv. A cheque in the sum of £335 in respect of the appropriate fee

As we own the freehold interest of the site, no other landowner need be notified. In view of the nature of the apparatus proposed, which is no relevance to the radio emissions, it is not necessary to provide an ICNIRP certificate. We have looked at limiting the development as much as possible to lessen the visual impact and the proposal put forward in our view is the best, We hope you are able to confirm that your Council does not need to approve its detailed siting and appearance. To that end, we refer you to Form 2 of Annex H of the Code of Best Practice on Mobile Phone Network Development, which is applicable in these circumstances. However, if you do determine that you would like to control the details, the plans submitted should enable you to approve such. If however, you have any queries about the development, please let us know immediately.

In writing to you, please also take this application and the details contained within it as due notification under the relevant condition of the Electronic Communications Code (Conditions and Restrictions) Regulations 2003. In particular, you are given notice of our intention to install the electronic communications apparatus that is described in more detail in the application documentation (including the scale drawings) and to be located as shown on the application plans.


We trust everything is in order, but if you do require any further information or clarification, please do not hesitate to contact our Trevor Woodhouse on 07951 030048.

Yours faithfully



ARQIVA

AREA MAP

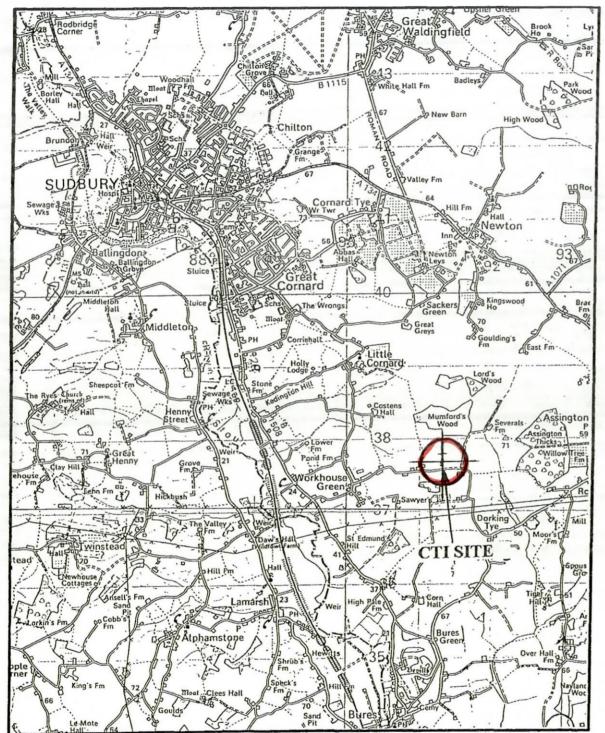

2200 5-665ha 14-00 CTI SITE 0670 7-063ha 3652 3-622ha 8-95

REPRODUCED FROM OS SHEET NO. TL 9037 1972. 1:2500 WITH THE PERMISSION OF THE CONTROLLER, H.M.S.O. @ CROWN COPYRIGHT. CASTLE TRANSMISSION INTERNATIONAL LTD. LICENCE NO. AL 52065A0001.

Castle Transmission International Ltd


NOTES

1) DO NOT SCALE DIMENSIONS.

2) ALL DIMENSIONS IN MILLIMETRES UNLESS OTHERWISE STATED.

BERGH DISTRICT COUNCIL PLANNING DEPARTMENT

3/09/00122

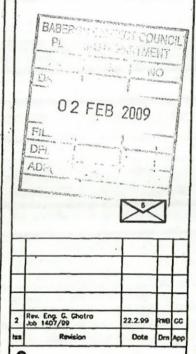

This drawing is the property of CASTLE TRANSMISSION INTERNATIONAL LTD and may not be reproduced or disclosed to a third party in any form without written permission

M

Castle Transmission International Ltd PO Box 98 CV34 6TN

SUDBURY


AREA & SITE LOCATION MAPS

Scole: 1:1 Drn: RWB Date: 22.2.99 App: GG

Drg No 10016.2.14/2

REPRODUCED FROM OS SHEET NO. 155. 1980 1:50,000
WITH THE PERMISSION OF THE CONTROLLER, H.M.S.O. © CROWN COPYRIGHT.
CASTLE TRANSMISSION INTERNATIONAL LTD. LICENCE NO. AL 52065A0001.


SITE MAP

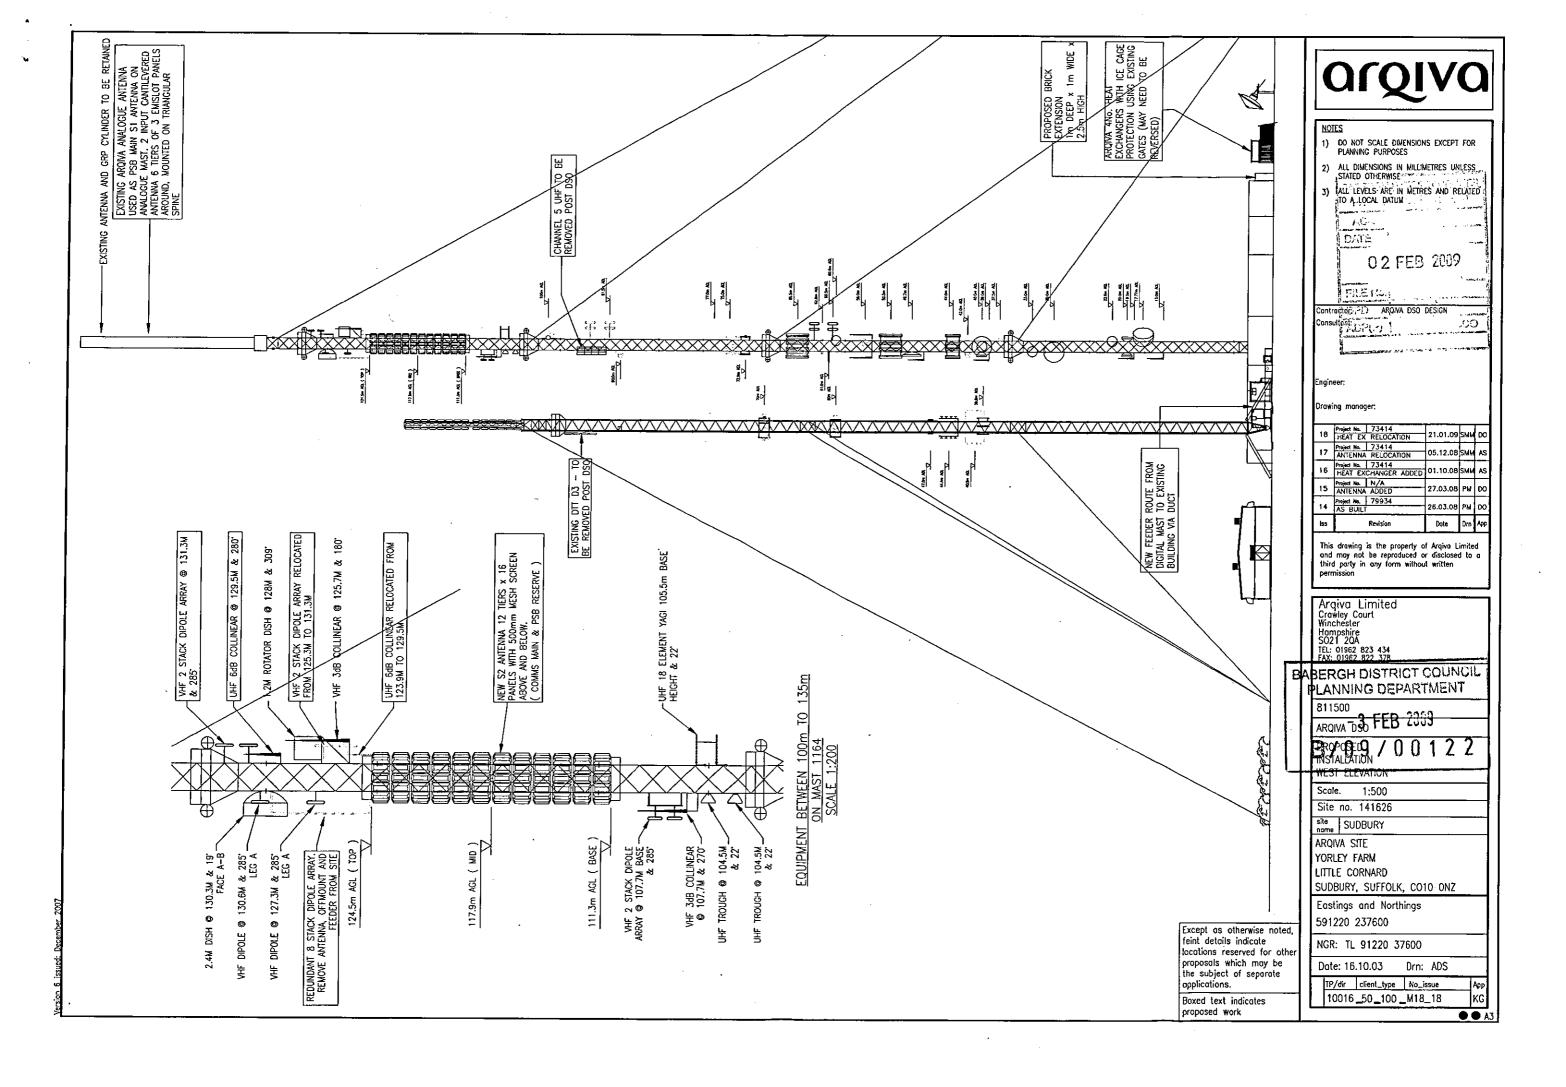

CUSTOMER				ARQIVA DSO				-			
SITE/STATION	ABBREVIATION	SUY						-			
SITE/STATION	CODE	115.00									
ANTENNA DETA	AILS: EXISTING	S			•						
MANUFACTURER	PART NUMBER	DESCRIPTION		MEAN	GHT BASE	BRG	MECH TILT	Tx/RBL	FEEDER Type	APPROX LENGTH	No. OF FEEDERS
-	<u> </u>	S2 ANTENNA 12	TIERS 16 PANELS	117.9		0		<u> </u>	4 1/8"	130	2


ALL BEARINGS MEASURED EAST OF TRUE NORTH ALL SIZES IN METRES

FEEDER LENGTHS HAVE BEEN SCALED FROM DRAWINGS AND ARE TO BE CONFIRMED BY SITE SURVEY

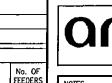

NOTES

- DO NOT SCALE DIMENSIONS EXCEPT FOR PLANNING PURPOSES
- 2) ALL DIMENSIONS IN MILLIMETRES UNLESS STATED OTHERWISE
- 3) ALL LEVELS ARE IN WETRES AND RELATED TO A LOCAL DATUM

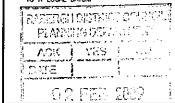

Contractor: A	roiva oso design
Consúllant: 📻 🏣	
	CHARLEST CONTRACTOR CONTRACTOR
7	A COLOR
2 3 4 5 1 1 1 1 1 1 1 1 1 1 1 1 1 1 1 1 1 1	The second secon

1				
	Project No. 73414			
18	HEAT EX RELOCATION	21.01.09		
	Project No. 73414	I		
17	ANTENNA RELOCATION	05.12.08		
	Project No. 73414			
16	HEAT EXCHANGER ADDED	01.10.08		
	Project No. N/A			
15	ANTENNA ADDED	27.03.08	PM	
	Project No. 79934			
14	AS BUILT	26.03.08	PM	۵
lss	Revision	Date	Ďm	Арр
		5310	5///	7

This drawing is the property of Argiva Limited and may not be reproduced or disclosed to a third party in any form without written

Argiva Limited Crowley Court

Windlester Harnedter RGH DISTRICT COUNCIL SOZI BEA SEINING DEPARTMENT FAX: 01962 822 378

-3 FEB 2009

ARQIVA-DSO

PROPOSED INSTALLATION HEADFRAME DETAILS

Scale. 1:25 Site no. 141626

site SUDBURY

ARQIVA SITE YORLEY FARM LITTLE CORNARD

SUDBURY, SUFFOLK, CO10 ONZ


Eastings and Northings 591220 237600

NGR: TL 91220 37600

Date: 16.10.03 Drn: ADS IP/dir client_type No_issue 10016_50_160 _M18_18

● ● A3




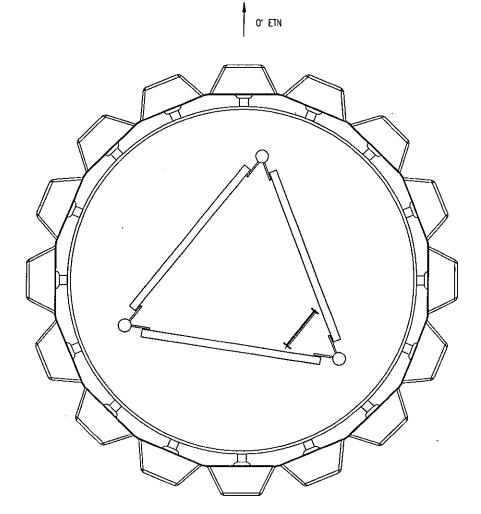


DSO ANTENNA MOUNTING PLAN @ 117.9m

Except as otherwise noted, feint details indicate locations reserved for other proposals which may be the subject of separate applications.


Boxed text indicates proposed work

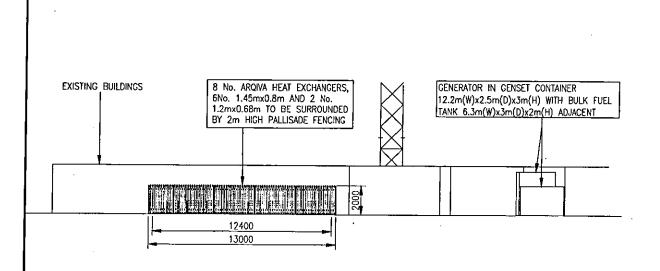


PART VIEW 'A' OF EAST ELEVATION
SCALE 1:250

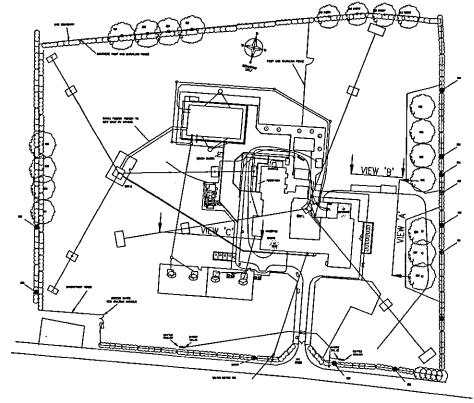

KEY PLAN FOR ELEVATION PART VIEWS SCALE 1:1500

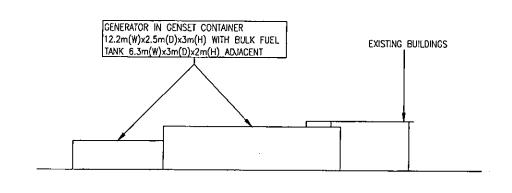

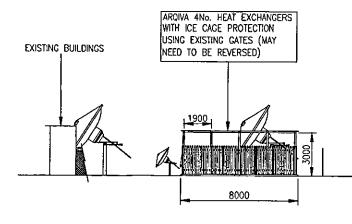



PART VIEW 'B' OF NORTH ELEVATION
SCALE 1:250

PART VIEW 'C' OF NORTH ELEVATION
SCALE 1:250

Except as otherwise noted, feint details indicate locations reserved for other proposals which may be the subject of separate opplications.

Boxed text indicates proposed work

arqiva

NOTES

- DO NOT SCALE DIMENSIONS EXCEPT FOR PLANNING PURPOSES
- 2) ALL DIMENSIONS IN MILLIMETRES UNLESS STATED OTHERWISE
- 3) ALL LEVELS ARE IN METRES AND RELATED TO A LOCAL DATUM

Contractor: ARQIVA DSO DESIGN Consultant:

Engineer

Drawing manager:

1						
ſ	4.0	Project No.	73414			
18	פֿי	HEAT EX	21.01.09	SMM	DC.	
		Project No.	73414			Π.
	17	ANTENNA	RELOCATION	05.12,08		H
		Project No.				
16	16	HEAT EX	01.10,08	SMM	A:	
	4-	Project Na.	N/A			
Į	15	ANTENNA		27.03.08	Н	DO
Г		Project No.	79934			
	14	AS BUILT	26.03,08	РМ	DO	
	lss		Date	Orn	App	
		<u> </u>				

This drawing is the property of Argiva Limited and may not be reproduced or disclosed to a third porty in any form without written permission

EABGYOCHIDISTRICT COLINCIL Grawley Court of DEPARTMENT Hampshire S021 202

TEL: 01962 823 414 EB 2003 FAX: 01962 823 318 EB 2003

B/09/00122

811500

ARQIVA DSO

PROPOSED

INSTALLATION
NORTH AND WEST PART ELEVATIONS

Scale. RT

Site no. 141626

ARQIVA SITE

YORLEY FARM LITTLE CORNARD

SUDBURY, SUFFOLK, CO10 ONZ

Eastings and Northings

591220 237600

NGR: TL 91220 37600

Date: 16.10.03 Drn: ADS

10016_50_101 _M18_18

● ● A3

